WTP GENERATOR

DESIGN TEAM

OWNER

CITY OF ALBANY 33883 BERRY DRIVE NE ALBANY, OR 97322

CIVIL:

WESTECH
CHRIS BRUGATO
3841 FAIRVIEW INDUSTRIAL DR S#100
SALEM, OR 97302
503-585-2474

ELECTRICAL:

LANDIS CONSULTING 6446 FAIRWAY AVE SE, SUITE 220 SALEM, OR 97306 503-584-1576

SHEET INDEX

GENERAL

G001 - COVER SHEET & SHEET INDEX

ELECTRICAL


E001 - ELECTRICAL SYMBOL LEGEND & ABBREVIATIONS

E002 - ELECTRICAL SYMBOL LEGEND

E010 - ONE-LINE DIAGRAM E100 - ELECTRICAL SITE PLAN

E200 - ELECTRICAL ROOM PLAN


AREA MAP

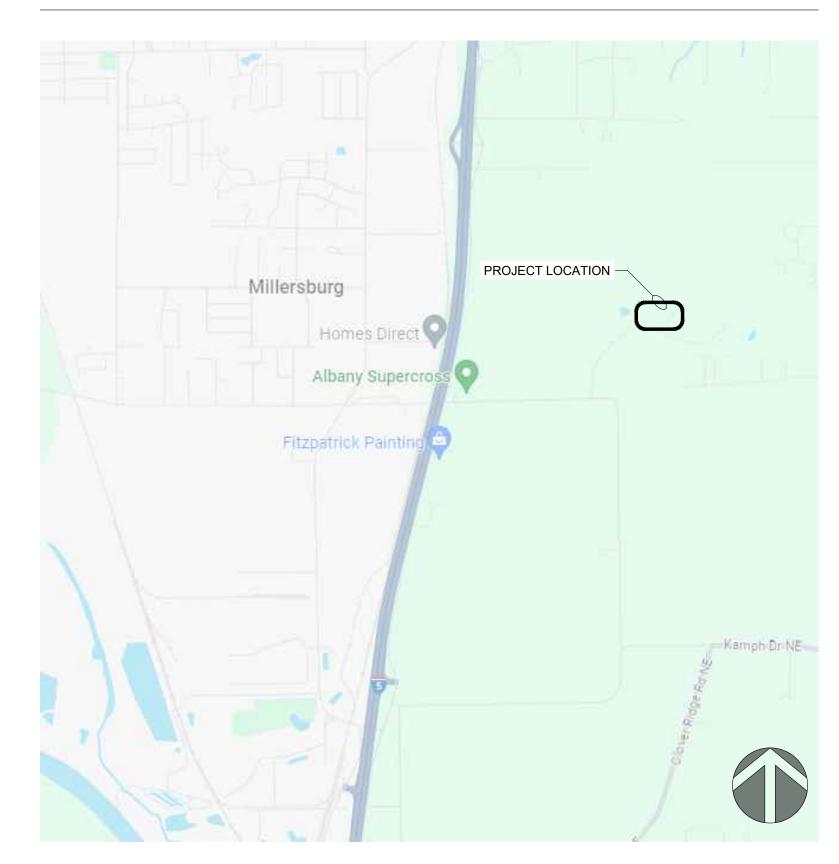

GENERAL NOTES:

- 1. ATTENTION: OREGON LAW REQUIRES THE CONTRACTOR TO FOLLOW RULES ADOPTED BY THE OREGON UTILITY NOTIFICATION CENTER. THOSE RULES ARE SET FORTH ON OAR 952-001-0001 THROUGH OAR 952-001-0090. CONTRACTOR MAY OBTAIN COPIES OF THE RULES BY CALLING THE CENTER. (NOTE: THE TELEPHONE FOR THE OREGON UTILITY NOTIFICATION CENTER IS (503) 232-1987).
- 2. THE CONTRACTOR SHALL BE RESPONSIBLE FOR PROTECTING AND AND ALL EXISTING UTILITIES AND OBTAINING UTILITY LOCATIONS PRIOR TO START OF CONSTRUCTION. THE CONTRACTOR MUST CONTACT OREGON UTILITY NOTIFICATION CENTER 811 OR 1-800-332-2344, A MINIMUM OF 48 HOURS PRIOR TO START OF CONSTRUCTION.
- 3. ALL EXCAVATED MATERIAL SHALL BE HAULED AND DISPOSED OF OFF SITE, UNLESS OTHERWISE NOTED.
- 4. ANY INSPECTION BY THE CITY, COUNTY, STATE, FEDERAL AGENCY, OR ENGINEER SHALL NOT, IN ANY WAY, RELIEVE THE CONTRACTOR FOR ANY OBLIGATION TO PERFORM THE WORK IN COMPLIANCE WITH THE APPLICABLE CODES, REGULATIONS, CITY STANDARDS, AND PROJECT CONTRACT DOCUMENTS.
- 5. THE CONTRACTOR IS RESPONSIBLE FOR POTHOLING TO VERIFY EXISTING UTILITY LOCATIONS AND ENSURE NO CONFLICTS EXIST PRIOR TO CONSTRUCTION.
- NOT ALL TREES, SHRUBS, AND HARDSCAPES ARE SHOWN ON THE PLANS, CONTRACTOR SHALL VISIT EACH LOCATION TO DETERMINE EXTEND OF REQUIRED CLEARING, GRUBBING AND RESTORATION.

VICINITY MAP

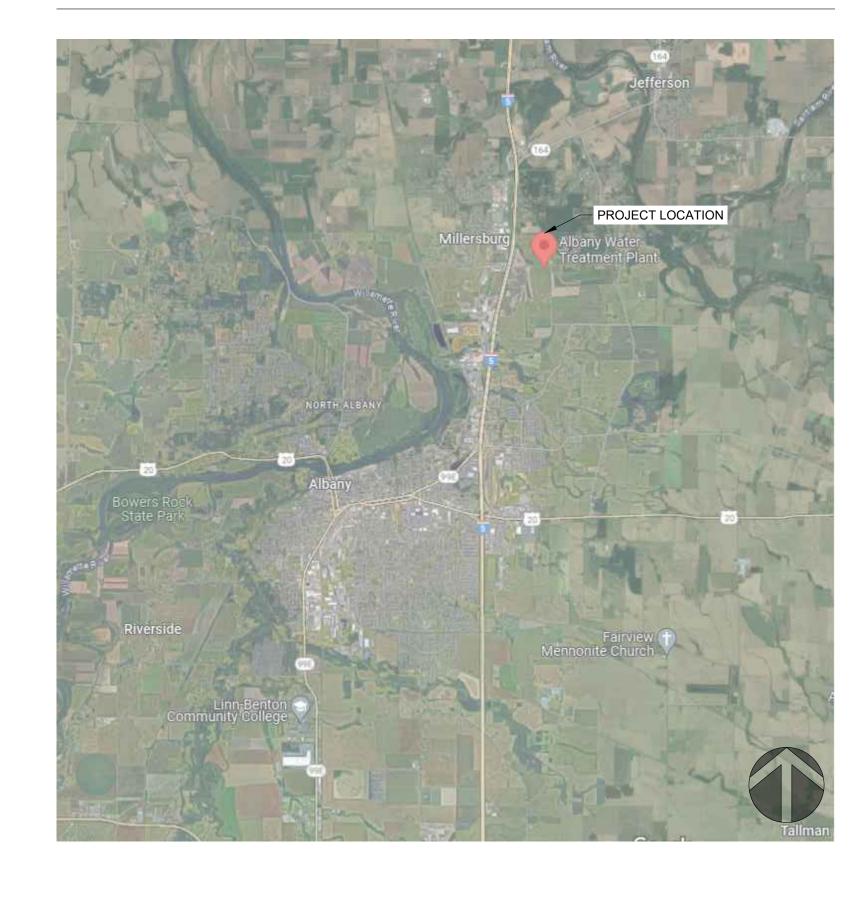

andis Consultir
IGINEERING SERVICE
Salem | Lake Oswego
503-584-1576
www.landisconsulting.com

Consultants







MEH

MEH

Design

Drawn

Checked

Drawing No.

Date 10/08/2024

Proj. No. 7022301

G001

Electrical Abbreviations, General Notes, & Symbol Legend

Abbreviations

Α	AMPERE		
AC	ALTERNATING CURRENT, AIR CONDITIONING UNIT	LAN	LOCAL AREA NETWORK
	AUTHORITY HAVING JURISDICTION	LCP	LOCAL CONTROL PANEL
AHJ			
Al	ANALOG INPUT	LCS	LOCAL CONTROL STATION
AIC	AVAILABLE INTERRUPTING CAPACITY	LED	LIGHT EMITTING DIODE
AF	AMPERE FRAME / AMPERE FUSED	LEL	LOWER EXPLOSIVE LEVEL
AFC	ABOVE FINISHED CEILING	LRG	LOW RESISTANCE GROUND
AFF	ABOVE FINISHED FLOOR	LS	LIMIT SWITCH
AFG	ABOVE FINISHED GRADE	LSI	ELECTRONIC TRIP UNIT ADJUSTABLE LONG TIME DELAY, SHORT TIME
AL	ALUMINUM		DELAY, INSTANTANEOUS TRIP
ANSI	AMERICAN NATIONAL STANDARDS INSTITUTE	LSIG	ELECTRONIC TRIP UNIT WITH ADJUSTABLE LONG TIME DELAY, SHORT TIME
		LSIG	,
AO	ANALOG OUTPUT		DELAY, INSTANTANEOUS TRIP, AND GROUND FAULT
ARMS	ARC FLASH REDUCTION MAINTENANCE SYSTEM	LV	LOW VOLTAGE
AT	AMPERE TRIP		
	AUDIO / VIDEO	MCA	MINIMUM CIRCUIT AMPACITY
AV		MCA	
AWG	AMERICAN WIRE GAUGE	MCC	MOTOR CONTROL CENTER
		MCP	MOTOR CIRCUIT PROTECTOR
BAS	BUILDING AUTOMATION SYSTEM	MDF	MAIN DISTRIBUTION FRAME
BFG	BELOW FINISHED GRADE	MHz	MEGAHERTZ
BLDG	BUILDING	MISC	MISCELLANEOUS
		MLO	MAIN LUGS ONLY
С	CONDUIT	MOCP	MAXIMUM OVERCURRENT PROTECTION
CAT#	CATEGORY #	MSC	MANUFACTURER SUPPLIED CABLE
CB	CIRCUIT BREAKER	MV	MEDIUM VOLTAGE
CFM	CUBIC FEET PET MINUTE	MVA	MEGAVOLT AMPERES
CFCI	CONTRACTOR FURNISHED, CONTRACTOR INSTALLED	MW	MEGAWATT
CFOI	CONTRACTOR FURNISHED, OWNER INSTALLED		
CKT	CIRCUIT	N	NEUTRAL
CP	CONTROL PANEL	NAC	NOTIFICATION APPLIANCE CIRCUIT
CPT	CONTROL POWER TRANSFORMER	N/A	NOT APPLICABLE
CR	CONTROL RELAY	NC	NORMALLY CLOSED
CSC	CONTRACTOR SUPPLIED CABLE	NEC	NATIONAL ELECTRICAL CODE
CU	COPPER	NEMA	NATIONAL ELECTRICAL MANUFACTURERS ASSOCIATION
		NEX	REPLACE EXISTING WIRING DEVICE AND FACEPLATE WITH NEW.
dB	DECIBAL		BACK BOX AND CONDUIT SHALL REMAIN.
		NII	
DC	DIRECT CURRENT	NL	NIGHT LIGHT
DI	DIGITAL INPUT	NO	NORMALLY OPEN
DIM	DIMENSION	NTS	NOT TO SCALE
DIV	DIVISION		
		0.0	ON OFNITED
DO	DIGITAL OUTPUT	OC	ON CENTER
DTL	DETAIL	OFCI	OWNER FURNISHED, CONTRACTOR INSTALLED
DWG	DRAWING	OFOI	OWNER FURNISHED, OWNER INSTALLED
2110		01 01	OWNER TOTAL OF THE PROPERTY OF
E/ID		~	DUA OF
E/IP	ETHERNET IP	Ø	PHASE
EF	EXHAUST FAN		
EL	ELEVATION	PB	PULL BOX, PANIC BUTTON, PUSH BUTTON
EMT	ELECTRICAL METALLIC TUBING		,
		PCP	PUMP CONTROL PANEL
EOLR	END OF LINE RESISTOR	PDP	PUMP DISCONNECT PANEL
		PE	PHOTO EYE
FACP	FIRE ALARM CONTROL PANEL	PLC	PROGRAMMABLE LOGIC CONTROLLER
FE	FLOWMETER ELEMENT	PNL	PANEL
FF	FINISH FLOOR	POE	POWER OVER ETHERNET
FIT	FLOWMETER TRANSMITTER	PPM	PARTS PER MILLION
FLA	FULL LOAD AMPERES	PTZ	PAN, TILT, ZOOM
FT	FOOT, FEET		
FBO	FURNISHED BY OTHERS	RF	RADIO FREQUENCY
-		RFI	REQUEST FOR INFORMATION
C OND	CROLIND	INII	THE SOLUTION IN CONVITATION
G, GND	GROUND		
GFCI	GROUND FAULT CIRCUIT INTERRUPTER	SCADA	SUPERVISORY CONTROL AND DATA ACQUISTION
		SLC	SIGNALING LINE CIRCUIT
HH	HAND HOLE	SPD	SURGE PROTECTION DEVICE
HP	HORSEPOWER	STD	STANDARD
HRG	HIGH RESISTANCE GROUND	SW	SWITCH
H2S	HYDROGEN SULFIDE	SWBD	SWITCHBOARD
: : -		SWGR	SWITCHGEAR
ID		SWUR	OWNIONOLAN
ID	IDENTIFICATION		
IDC	INITIATING DEVICE CIRCUIT	T/M	THERMAL MAGNETIC CIRCUIT BREAKER
IDF	INTERMEDIATE DISTRIBUTION FRAME	TBD	TO BE DETERMINED
IEEE	INSTITUTE OF ELECTRICAL AND ELECTRONICS ENGINEERS	TSP	TWISTED SHIELDED PAIR
IG	ISOLATED GROUND	TV	TELEVISION / MONITOR OUTLET
IT	INFORMATION TECHNOLOGY	TVSS	TRANSIENT VOLTAGE SURGE SUPPRESSOR
I/O	INPUT / OUTPUT	TYP	TYPICAL
1/0		117	ITIOAL
JB	JUNCTION BOX	UH	UNIT HEATER
		UG	UNDERGROUND
KAIC	THOUSAND AMPS INTERRUPTING CURRENT	UL	UNDERWRITERS LABORATORIES
KCMIL	THOUSAND CIRCULAR MILS	UPS	UNINTERRUPTIBLE POWER SUPPLY
KVA	KILOVOLT-AMPERE	UON	UNLESS OTHERWISE NOTED
KW	KILOWATT	USB	UNIVERSAL SERIAL BUS
		305	

- 2. ALL 20-AMP RECEPTACLE AND HARDWIRED BRANCH
- 3. ALL EXIT SIGNS SHALL BE WIRED TO THE LOCAL LIGHTING BRANCH CIRCUIT AHEAD OF ALL SWITCHING.
- WHICH ARE CONTROLLED BY 0-10V DIMMERS SHOWN ON THE DRAWINGS.
- 5. ALL ELEVATION HEIGHTS SHALL BE TO CENTERLINE OF EQUIPMENT OR DEVICE UNLESS OTHERWISE NOTED.

VOLTS, VOLTAGE VOLT-AMPERE

WATT, WIRE

WITH

WYE

ONE POLE

TWO POLE THREE POLE

FOUR POLE

WITHOUT

VARIABLE FREQUENCY DRIVE

WITHSTAND CURRENT RATING

WIRELESS ACCESS POINT

WIRELESS FIDELITY

TRANSFORMER

TRANSMITTER

INDICATES EXISTING EQUIPMENT TO BE

CONDUIT & CONDUCTOR CALLOUT. REFER TO

CORRESPONDING SHEET KEYNOTES

CORRESPONDING SHEET KEYNOTES.

MECHANICAL EQUIPMENT CALLOUT. REFER TO MECHANICAL EQUIPMENT CONNECTION SCHEDULE.

FIXTURE MOUNTING CALLOUT. HEIGHT ABOVE

(A.F.G.) FOR EXTERIOR

EQUIPMENT CALLOUT. REFER TO NEMA CONNECTION SCHEDULE.

SECTION CALLOUT. REFER TO SECTION AND SHEET AS INDICATED ON CALLOUT.

ELEVATION CALLOUT. REFER TO ELEVATION AND

General Electrical Notes

1. ALL LIGHTING BRANCH CIRCUITS SHALL BE 2#10, 1#10G IN 3/4" CONDUIT, UON.

CIRCUITS SHALL BE 2#12, 1#12G IN 3/4" CONDUIT, UON.

4. PROVIDE 0-10V DIMMING CONDUCTORS TO ALL LUMINAIRES

Annotation

INDICATES NEW EQUIPMENT.

INDICATES EXISTING EQUIPMENT TO REMAIN.

DEMOLISHED.

INDICATED EXISTING EQUIPMENT OR DEVICE TO BE REMOVED AND REINSTALLED.


> CONDUIT & CONDUCTOR SCHEDULE. KEYED NOTE CALLOUT. REFER TO

KEYED NOTE CALLOUT. REFER TO KEYED NOTE CALLOUT. REFER TO

CORRESPONDING SHEET KEYNOTES.


DETAIL CALLOUT. REFER TO DETAIL AND SHEET AS INDICATED ON CALLOUT.

FINISHED FLOOR (A.F.F.) FOR INTERIOR OR GRADE

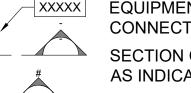

SHEET AS INDICATED ON CALLOUT.

Consultants

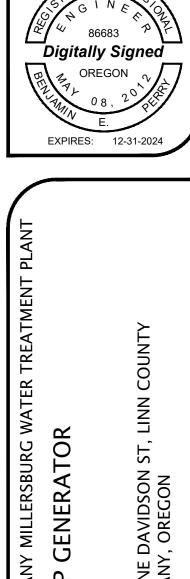

ELECTRICAL SYMBOL

LEGEND & ABBREVIATIONS

Checked Proj. No. 7022301 Drawing No.

Electrical Symbol Legend

Power	Distribution	Lighting	
Φ	DUPLEX RECEPTACLE, MOUNTED AT 18" AFF, UON.		TROFFER LUMINAIRE, SURFACE OR RECESS
Ф	SIMPLEX RECEPTACLE, MOUNTED AT 18" AFF, UON.		MOUNTED AS INDICATED ON THE DRAWINGS.
#	QUADPLEX RECEPTACLE, MOUNTED AT 18" AFF, UON.		DOWNLIGHT LUMINAIRE, SURFACE, RECESS, OR PENDANT MOUNTED AS INDICATED ON THE DRAWINGS.
\Diamond	GFCI DUPLEX RECEPTACLE, MOUNTED AT 18" AFF, UON.		UNDERCABINET LUMINAIRE.
*	GFCI QUADPLEX RECEPTACLE, MOUNTED AT 18" AFF, UON.	+ +	EMERGENCY BATTERY PACK LUMINAIRE, WALL OR CEILING MOUNTED.
Image: Control of the	TAMPER RESISTANT DUPLEX RECEPTACLE, MOUNTED AT 18" AFF, UON.	0 0	LINEAR PENDANT MOUNTED LUMINAIRE.
#	TAMPER RESISTANT QUADPLEX RECEPTACLE, MOUNTED AT 18" AFF, UON.		LINEAR WALL MOUNTED LUMINAIRE.
Φ	SWITCHED DUPLEX RECEPTACLE, MOUNTED AT 18" AFF, UON.	☆	BOLLARD LUMINAIRE.
\Diamond	NEMA SPECIAL RECEPTACLE, MOUNTED AT 18" AFF, UON. NEMA CONFIGURATION AS INDICATED.	~~``	SITE LUMINAIRE POLE MOUNTED. NUMBER OF
	CENTER HATCHED RECEPTACLE TO BE WIRED TO EMERGENCY CIRCUIT.		HEADS AS SHOWN.
\Box	RECEPTACLE MOUNTED ON CEILING.		TRACK LUMINAIRE.
Ф	RECEPTACLE MOUNTED IN-COUNTER.	Q	SPOT LUMINAIRE.
4	DISCONNECT SWITCH.	9	WALL MOUNTED LUMINAIRE.
	FUSED DISCONNECT SWITCH.	_	WALL MOONTED LOWING MIXE.
4	ENCLOSED CIRCUIT BREAKER.		EXIT SIGN, WALL OR CEILING MOUNTED, SINGLE FACE WITH DIRECTIONAL CHEVRONS AS INDICATED
	COMBINATION STARTER.	4624	ON DRAWINGS.
	FLOORBOX COMBINATION POWER & DATA.		EXIT SIGN, WALL OR CEILING MOUNTED, DOUBLE FACE WITH DIRECTIONAL CHEVRONS AS INDICATED ON DRAWINGS.
	FLOORBOX POWER.		HALF HATCHED LUMINAIRE TO BE WIRED TO
	POKETHRU COMBINATION POWER & DATA.		EMERGENCY CIRCUIT.
	POKETHRU POWER. POWER/DATA POLE.		FULL HATCHED LUMINAIRE TO BE WIRED TO NIGHTLIGHT CIRCUIT.
	PANELBOARD SURFACE MOUNT.	\bigcirc	WALL WASH LUMINAIRE POINTED IN DIRECTION AS
	PANELBOARD FLUSH MOUNT.		SHOWN
	MAIN DISTRIBUTION PANEL.	D • • • • • •	
	WAIN DISTRIBUTION FAINEL.	Racewa	ays
	UTILITY CT METER.		CONDUIT AND/OR CONDUCTORS INSTALLED ABOVE
	UTILITY TRANSFORMER.		GRADE, CONCEALED IN WALL OR CEILING SPACE. CONDUIT AND/OR CONDUCTORS INSTALLED BELOW
<u>Orawir</u>	ng Symbol Variables		GRADE, BELOW SLAB. CONDUIT TURNED DOWN.
3	THREE WAY SWITCH.		CONDUIT TURNED UP.
4 #J	FOUR WAY SWITCH. QUANTITY OF JACKS AND HORIZONTAL CABLES.		CONDUIT STUBBED AND CAPPED.
+XX	J = CAT6, JA = CAT6A, JE = CAT5E MOUNTING UNITS EXPRESSED IN INCHES TO		CONDUIT DIRECT CONNECTION TO EQUIPMENT.

FLEXIBLE CONNECTION TO EQUIPMENT.

MOUNTED AT 42" AFF, UON.

ADA DOOR PUSHPLATE.

HOMERUN TO PANELBOARD.

MOUNTED.

Switches

• ••

CONDUIT / WIRING CONTINUATION.

CABLE TRAY. SIZE AND TYPE AS INDICATED ON

SINGLE POLE SWITCH - MOUNTED AT 42" AFF, UON.

LOW VOLTAGE 0-10 VOLT DIMMING SWITCH -

OCCUPANCY SENSOR - CEILING OR WALL

PHOTOCELL - CEILING OR WALL MOUNTED.

EMERGENCY STOP SWITCH, MUSHROOM HEAD.

OCCUPANCY SENSOR POWER PACK.

PUSHBUTTON, SINGLE OR DOUBLE.

Diawi	ng Cymbol Variables
3	THREE WAY SWITCH.
4	FOUR WAY SWITCH.
#J	QUANTITY OF JACKS AND HORIZONTAL CABLES.
110	J = CAT6, JA = CAT6A, JE = CAT5E
+XX	MOUNTING UNITS EXPRESSED IN INCHES TO
701	CENTERLINE ABOVE FINISHED FLOOR OR GRADE.
С	MOUNTED HORIZONTALLY AT 4" ABOVE
O	COUNTERTOP.
CL	CLOCK.
DR	DUAL RELAY.
E	RED EMERGENCY SWITCH.
EL	ELEVATOR RECALL.
ETR	EXISTING DEVICE SHALL REMAIN.
G	GLASS BREAK SENSOR.
K	KEYED SWITCH.
LF	LOW FREQUENCY.
LV	LOW FREGOENCY: LOW VOLTAGE SWITCH.
M	MOTOR RATED TOGGLE SWITCH.
NEX	REPLACE EXISTING WIRING DEVICE AND FACEPLATE
INLX	WITH NEW. BACK BOX AND CONDUIT SHALL REMAIN.
0	INTEGRAL OCCUPANCY SENSOR.
P	ADA PHONE, VERIFY HEIGHT WITH ARCHITECT /
Г	OWNER.
REX	REMOVE EXISTING DEVICE / EQUIPMENT.
TK	MOUNTED IN TOE KICK OF CASEWORK.
TV	MOUNTED IN TOE RICK OF CASEWORK. MOUNTED ADJACENT TO TV AT 60" AFF, UON.
V	•
-	VANDAL RESISTANT.
WG	WIREGUARD.
WP	WEATHERPROOF.

─ ₀′ ` ○ ─	CIRCUIT BREAKER.
< <o^o>>></o^o>	DRAWOUT CIRCUIT BREAKER.
	ENCLOSED CIRCUIT BREAKER.
0-X-1-0	MOTOR STARTER CONTACT.
	DISCONNECT SWITCH.
	ENCLOSED DISCONNECT SWITCH.
	FUSED DISCONNECT SWITCH.
	ENCLOSED FUSED DISCONNECT SWITCH.
M	CURRENT TRANSFORMER METER.
	FUSE, RATING AS SHOWN ON DRAWINGS.
	GENERATOR, CONFIGURATION AS INDICATED ON DRAWING.
	GROUND ROD.
<u></u>	EQUIPMENT GROUND.
\bigvee	MOTOR, RATED AS INDICATED ON DRAWINGS.
	NEMA CONNECTION.
NAME	PANEL.
NAME	MINI POWER CENTER.
ST)—	SHUNT TRIP.
HTR	HEATER.
RA	REMOTE ANNUNCIATOR.
BATT	BATTERY CHARGER.
SPD	SURGE PROTECTION DEVICE.
DM	DIGITAL METER.
K	KIRK KEY.
VFD	VARIABLE FREQUENCY DRIVE.
SS	SOFT STARTER.
NO_OE	TRANSFER SWITCH, WITH FUSES OR BREAKERS AS SHOWN ON DRAWINGS.
	TRANSFORMER.
Miscell	aneous
J J	JUNCTION BOX (ROUND, SQUARE).

(J) [J]	JUNCTION BOX (ROUND, SQUARE).
T	THERMOSTAT.
R	RELAY.
Ą	CORD REEL.
	MOTOR / EXHAUST FAN.
	CEILING FAN.
	UTILITY POLE.
7	WEATHERHEAD.
\otimes	GROUND ROD.
\bigotimes	GROUND ROD WITH TEST WELL.
	SURFACE RACEWAY / WIREMOLD.
	FIRE RATED BACKBOARD.

GROUND BUS BAR.

Access Control & Security

ACCESS CONTROL - DOOR CONTACT. PROVIDE 3/4"
CONDUIT FROM DOOR FRAME TO ACCESSIBLE
CEILING OR SECURITY JUNCTION BOX AS SHOWN
ON THE DRAWINGS.

- ACCESS CONTROL CARD READER. PROVIDE 3/4" CONDUIT FROM DOOR FRAME TO ACCESSIBLE CEILING OR SECURITY JUNCTION BOX AS SHOWN ON THE DRAWINGS.
- ACCESS CONTROL ELECTRIC STRIKE. PROVIDE 3/4" CONDUIT FROM DOOR FRAME TO ACCESSIBLE CEILING OR SECURITY JUNCTION BOX AS SHOWN ON THE DRAWINGS.
- ACCESS CONTROL KEY PAD. PROVIDE 3/4" CONDUIT FROM DOOR FRAME TO ACCESSIBLE CEILING OR SECURITY JUNCTION BOX AS SHOWN ON THE DRAWINGS.
- ACCESS CONTROL MAGNETIC LOCK. PROVIDE 3/4" CONDUIT FROM DOOR FRAME TO ACCESSIBLE CEILING OR SECURITY JUNCTION BOX AS SHOWN ON THE DRAWINGS.
- ACCESS CONTROL REQUEST TO EXIT. PROVIDE 3/4" CONDUIT FROM DOOR FRAME TO ACCESSIBLE CEILING OR SECURITY JUNCTION BOX AS SHOWN ON THE DRAWINGS.
- ACCESS CONTROL ELECTRIFIED PANIC BAR. PROVIDE 3/4" CONDUIT FROM DOOR FRAME TO ACCESSIBLE CEILING OR SECURITY JUNCTION BOX AS SHOWN ON THE DRAWINGS.
- ACCESS CONTROL SECURITY JUNCTION BOX. SIZED AS RECOMMENDED BY SECURITY SYSTEM MANUFACTURER.
- ACCESS CONTROL CAMERA / INTERCOM.
- ACCESS CONTROL PANIC BUTTON.
- SECURITY CAMERA CEILING MOUNTED. PROVIDE ONE (1) CAT6.
- SECURITY CAMERA WALL MOUNTED. PROVIDE ONE (1) CAT6.
- INTRUSION SENSOR CEILING MOUNTED.
- **INTRUSION SENSOR WALL MOUNTED**
 - INTRUSION KEYPAD.


Low Voltage

- ETHERNET OUTLET MOUNTED AT 18" AFF, UON.
- COAXIAL OUTLET MOUNTED AT 18" AFF, UON.
- PHONE OUTLET MOUNTED AT 18" AFF, UON.
- LOW VOLTAGE OUTLET CEILING MOUNTED.
- WIRELESS ACCESS POINT CEILING MOUNTED.
- WIRELESS ACCESS POINT WALL MOUNTED.
- DIGITAL CLOCK.
- FLOORBOX DATA.
- POKETHRU DATA.
- IT RACK.
- VERTICAL WIRE MANAGEMENT.

Consultants






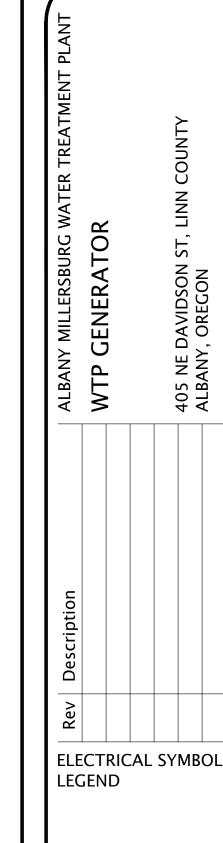

Design Drawn MEH Checked Date 10/08/2024

Proj. No. 7022301

Drawing No.

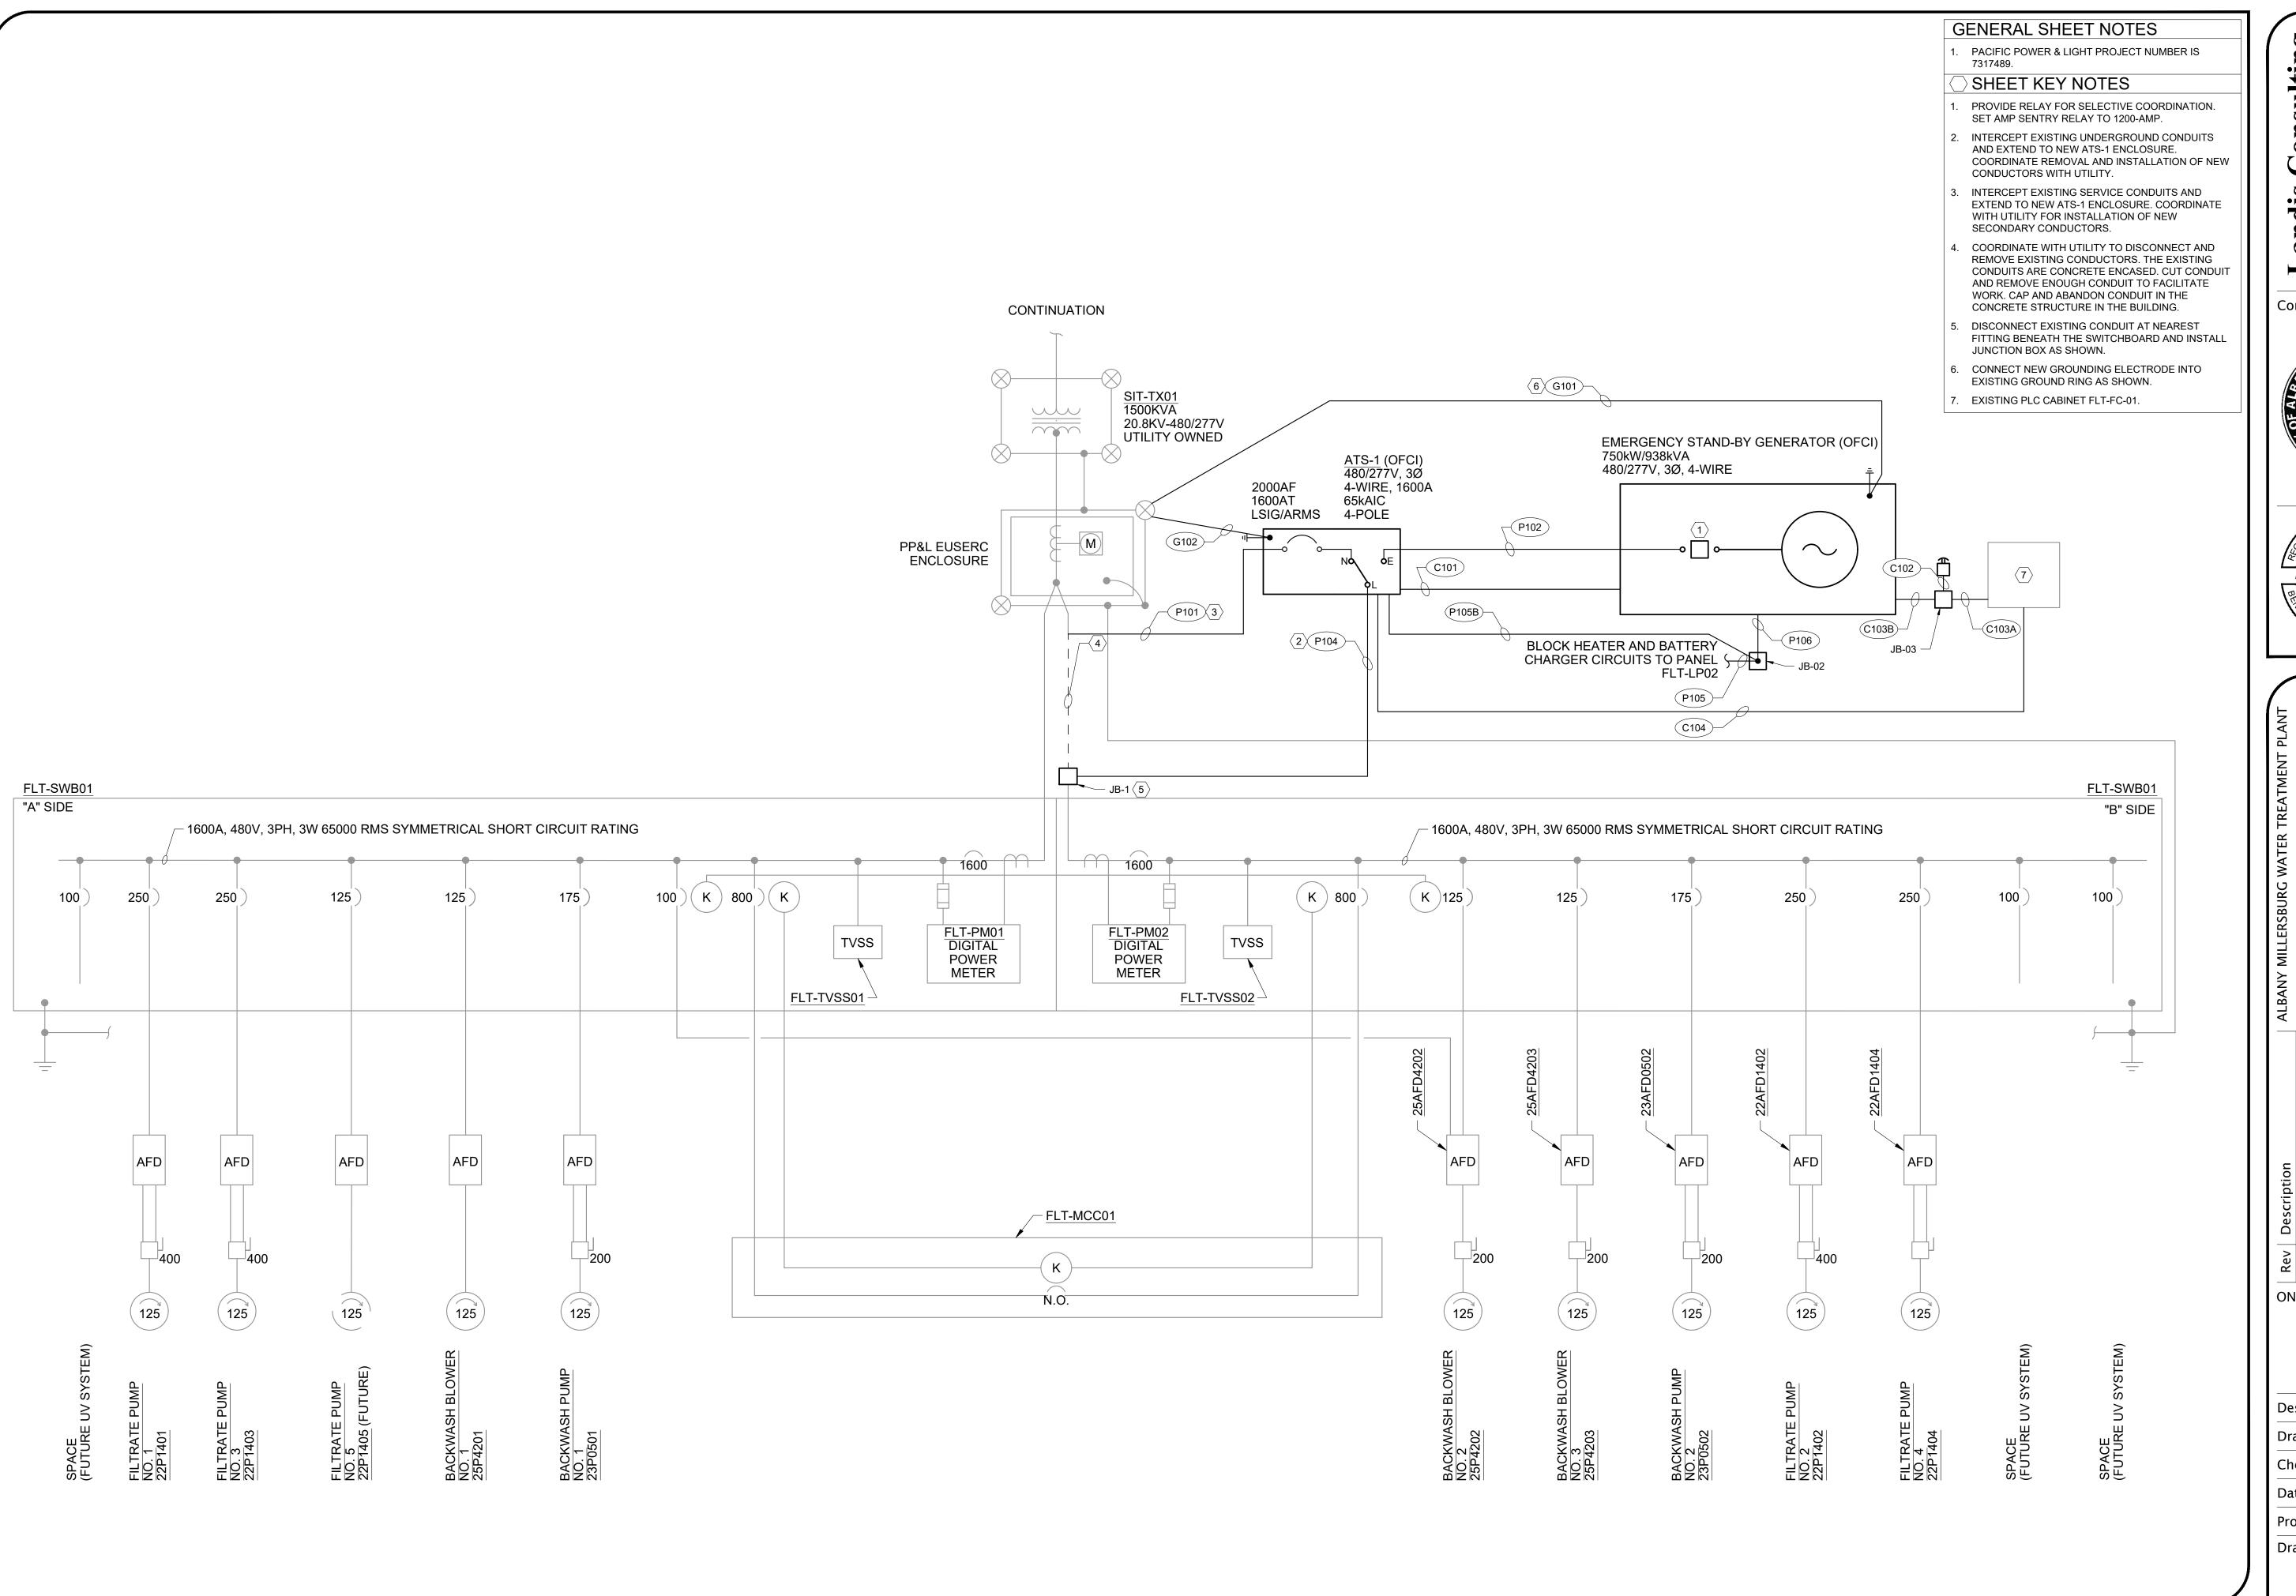

Consulting
RING SERVICES
n | Lake Oswego

Consultants





Rev Description

ALBANY MILLERSBURG WATER TREATMENT

WTP GENERATOR

WTP GENERATOR

405 NE DAVIDSON ST, LINN COUNTY

ALBANY, OREGON

Design MEH
Drawn EJC
Checked MEH
Date 10/08/2024

Proj. No. 7022301

Drawing No.

POWER CONDUIT / CONDUCTOR SCHEDULE													
CONDUIT ID	CON	DUIT		CONI	DUCTORS PER CON	DUIT		FROM	T0	DECORIDATION	NOTES		
NO.	QUANTITY	SIZE	UNGROUNDED	GROUNDED	GROUNDING	CABLE	SPARE	FROM	ТО	DESCRIPTION	NOTES		
P101	4	4.0 INCH	3 - #600	1 - #600	-	-	-	(E) PP&L EUSERC SWITCHBOARD	(N) MCB/ATS-1	INSTALL PER PP&L REQUIREMENTS	-		
P102	4	4.0 INCH	3 - #350	3 - #350	1 - #3/0	-	-	GENERATOR	(N) MCB/ATS-1	-	-		
PXXX	-	-	-	-	-	-	-	-	-	-	-		
P104	4	4.0 INCH	3 - #600	3 - #600	1 - #250	-	-	MCB/ATS-1	JB-1	-	-		
P105	1	0.75 INCH	2 - #10 1 - #10 1 - #10	- 1 - #10 1 - #10	1 - #10 1 - #10 1 - #10	-	-	(E) PANEL FLT LP02	GENERATOR BLOCK HEATER GENERATOR BATTERY CHARGER ATS SPACE HEATER	CIRCUITS #35,37 (VIA JB-02) CIRCUIT #39 (VIA JB-02) CIRCUIT #16 (VIA JB-02)	-		
P105B	1	0.75INCH	1 - #10	1 - #10	1 - #10	-	-	(E) PANEL FLT LP02	ATS SPACE HEATER	CIRCUIT #16	-		
P106	1	0.75 INCH	2 - #10 1 - #10	- 1 - #10	1 - #10 1 - #10	-	-	(E) PANEL FLT LP02	GENERATOR BLOCK HEATER GENERATOR BATTERY CHARGER	CIRCUITS #35,37 (VIA JB-02) CIRCUIT #39 (VIA JB-02)	-		

CONDUIT ID	CON	IDUIT		CONI	DUCTORS PER CON	NDUIT		FROM	ТО	DECODIDEION	NOTEO
NO.	QUANTITY	SIZE	UNGROUNDED	GROUNDED	GROUNDING	CABLE	SPARE	FROW	10	DESCRIPTION	NOTES
C101	1	0.75 INCH	2 - #14	-	1 - #14	-	-	(N) GENERATOR	(N) ATS-1	GENERATOR START COMMAND	-
C102	1	1.0 INCH	4 - #14	-	1 - #14	-	-	(N) GENERATOR	E-STOP	GENERATOR E-STOP	-
C103A	1	1.0 INCH	- 2 - #14 2 - #14 2 - #14 2 - #14	-	1 - #14	1	-	(E) PLC CABINET FLT-CP01	(N) JUNCTION BOX JB-03	EXISTING CONDUIT TO BE RE-USED GENERATOR ALARM GENERATOR RUNNING GENERATOR NOT IN AUTO GENERATOR LOW FUEL ALARM	-
C103B	1	1.0 INCH	2 - #14 2 - #14 2 - #14 2 - #14 2 - #14	-	1 - #14	-	-	(N) JUNCTION BOX JB-03	(N) GENERATOR	GENERATOR E-STOP GENERATOR ALARM GENERATOR RUNNING GENERATOR NOT IN AUTO GENERATOR LOW FUEL ALARM	-
C104	1	0.75 INCH	2 - #14 2 - #14	-	1 - #14	-	-	(N) ATS-1	(E) PLC CABINET FLT-CP01	ATS ON UTILITY POWER ATS ON GENERATOR POWER	-
C105	-	0.75 INCH	-	-	-	1 - #18TSP	-	(N) GENERATOR	(E) PLC CABINET FLT-CP01	GENERATOR FUEL LEVEL SENSOR	-

							GR	ROUNDING CONDUIT / CONDUCT	OR SCHEDULE		
CONDUIT ID	COND	CONDUIT CONDUCTORS PER CONDUIT						EROM	TO.	DESCRIPTION	NOTES
NO.	QUANTITY	SIZE	UNGROUNDED	GROUNDED	GROUNDING	CABLE	SPARE	FROM	10	DESCRIPTION	NOTES
G101	1	-	-	-	1 - #4/0	-	-	EMERGENCY STAND-BY GENERATOR	(E) GROUNDING ELECTRODE SYSTEM	-	-
G102	1	-	-	-	1 - #4/0	-	-	ATS-1	(E) GROUNDING ELECTRODE SYSTEM	-	-

Landis Consulting
ENGINEERING SERVICES
Salem | Lake Oswego
503-584-1576
www.landisconsulting.com

Consultants





Description

WTP GENERATOR

WTP GENERATOR

405 NE DAVIDSON ST, LINN COUNTY


ALBANY, OREGON


ELECTRICAL SCHEDULES

Design MEH
Drawn EJC
Checked MEH
Date 10/08/2024
Proj. No. 7022301
Drawing No.

SHEET KEY NOTES

1. DIMENSIONS PER SPECIFICATION.

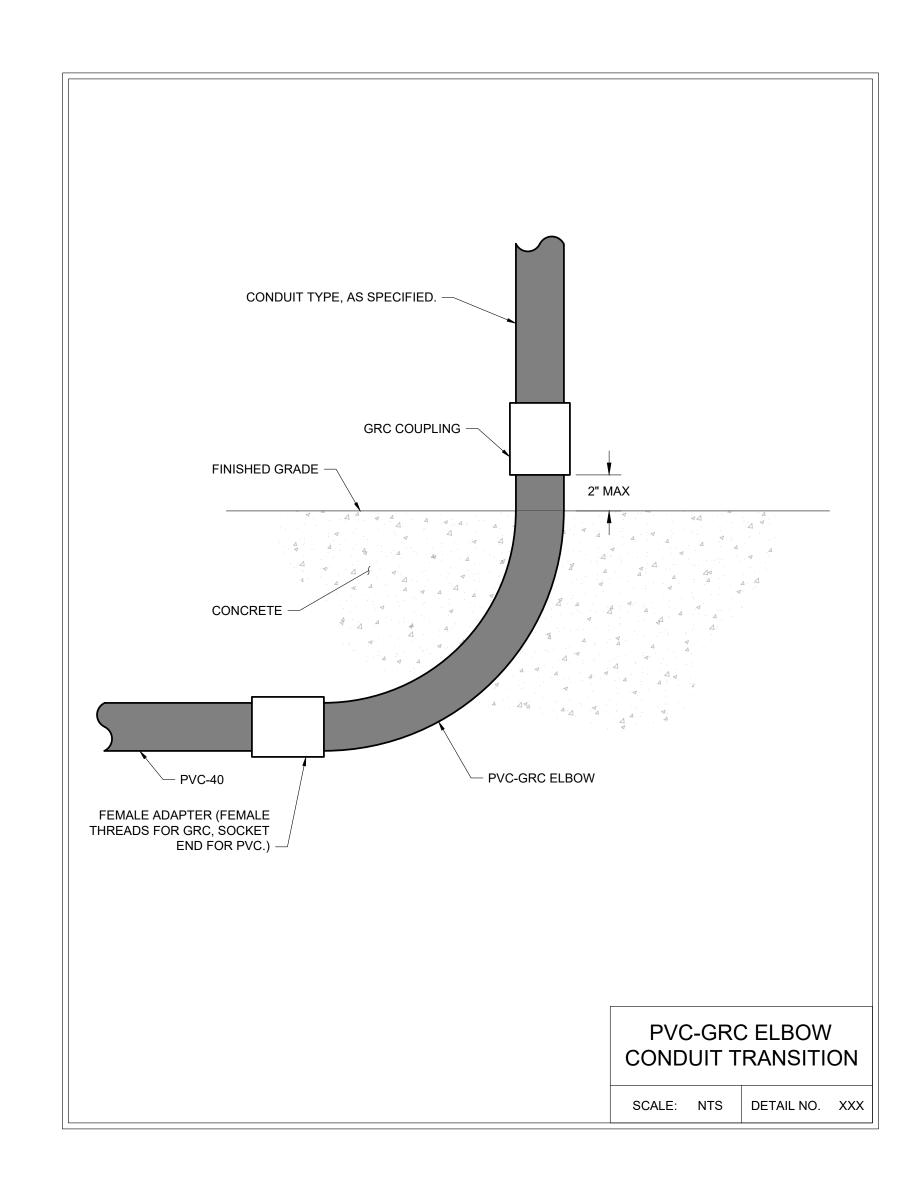


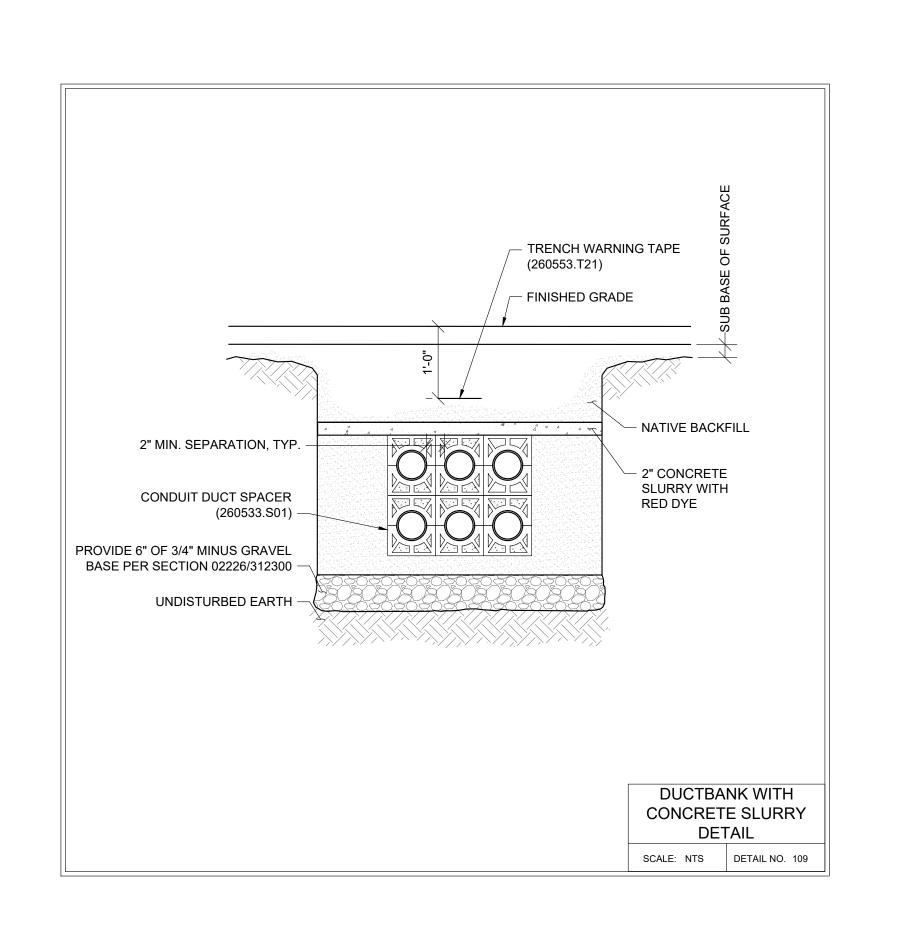

Consultants





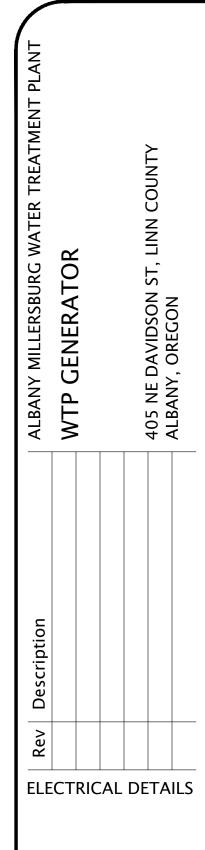


MEH Design Drawn

MEH Checked Date 10/08/2024

Proj. No. 7022301

Drawing No. E040

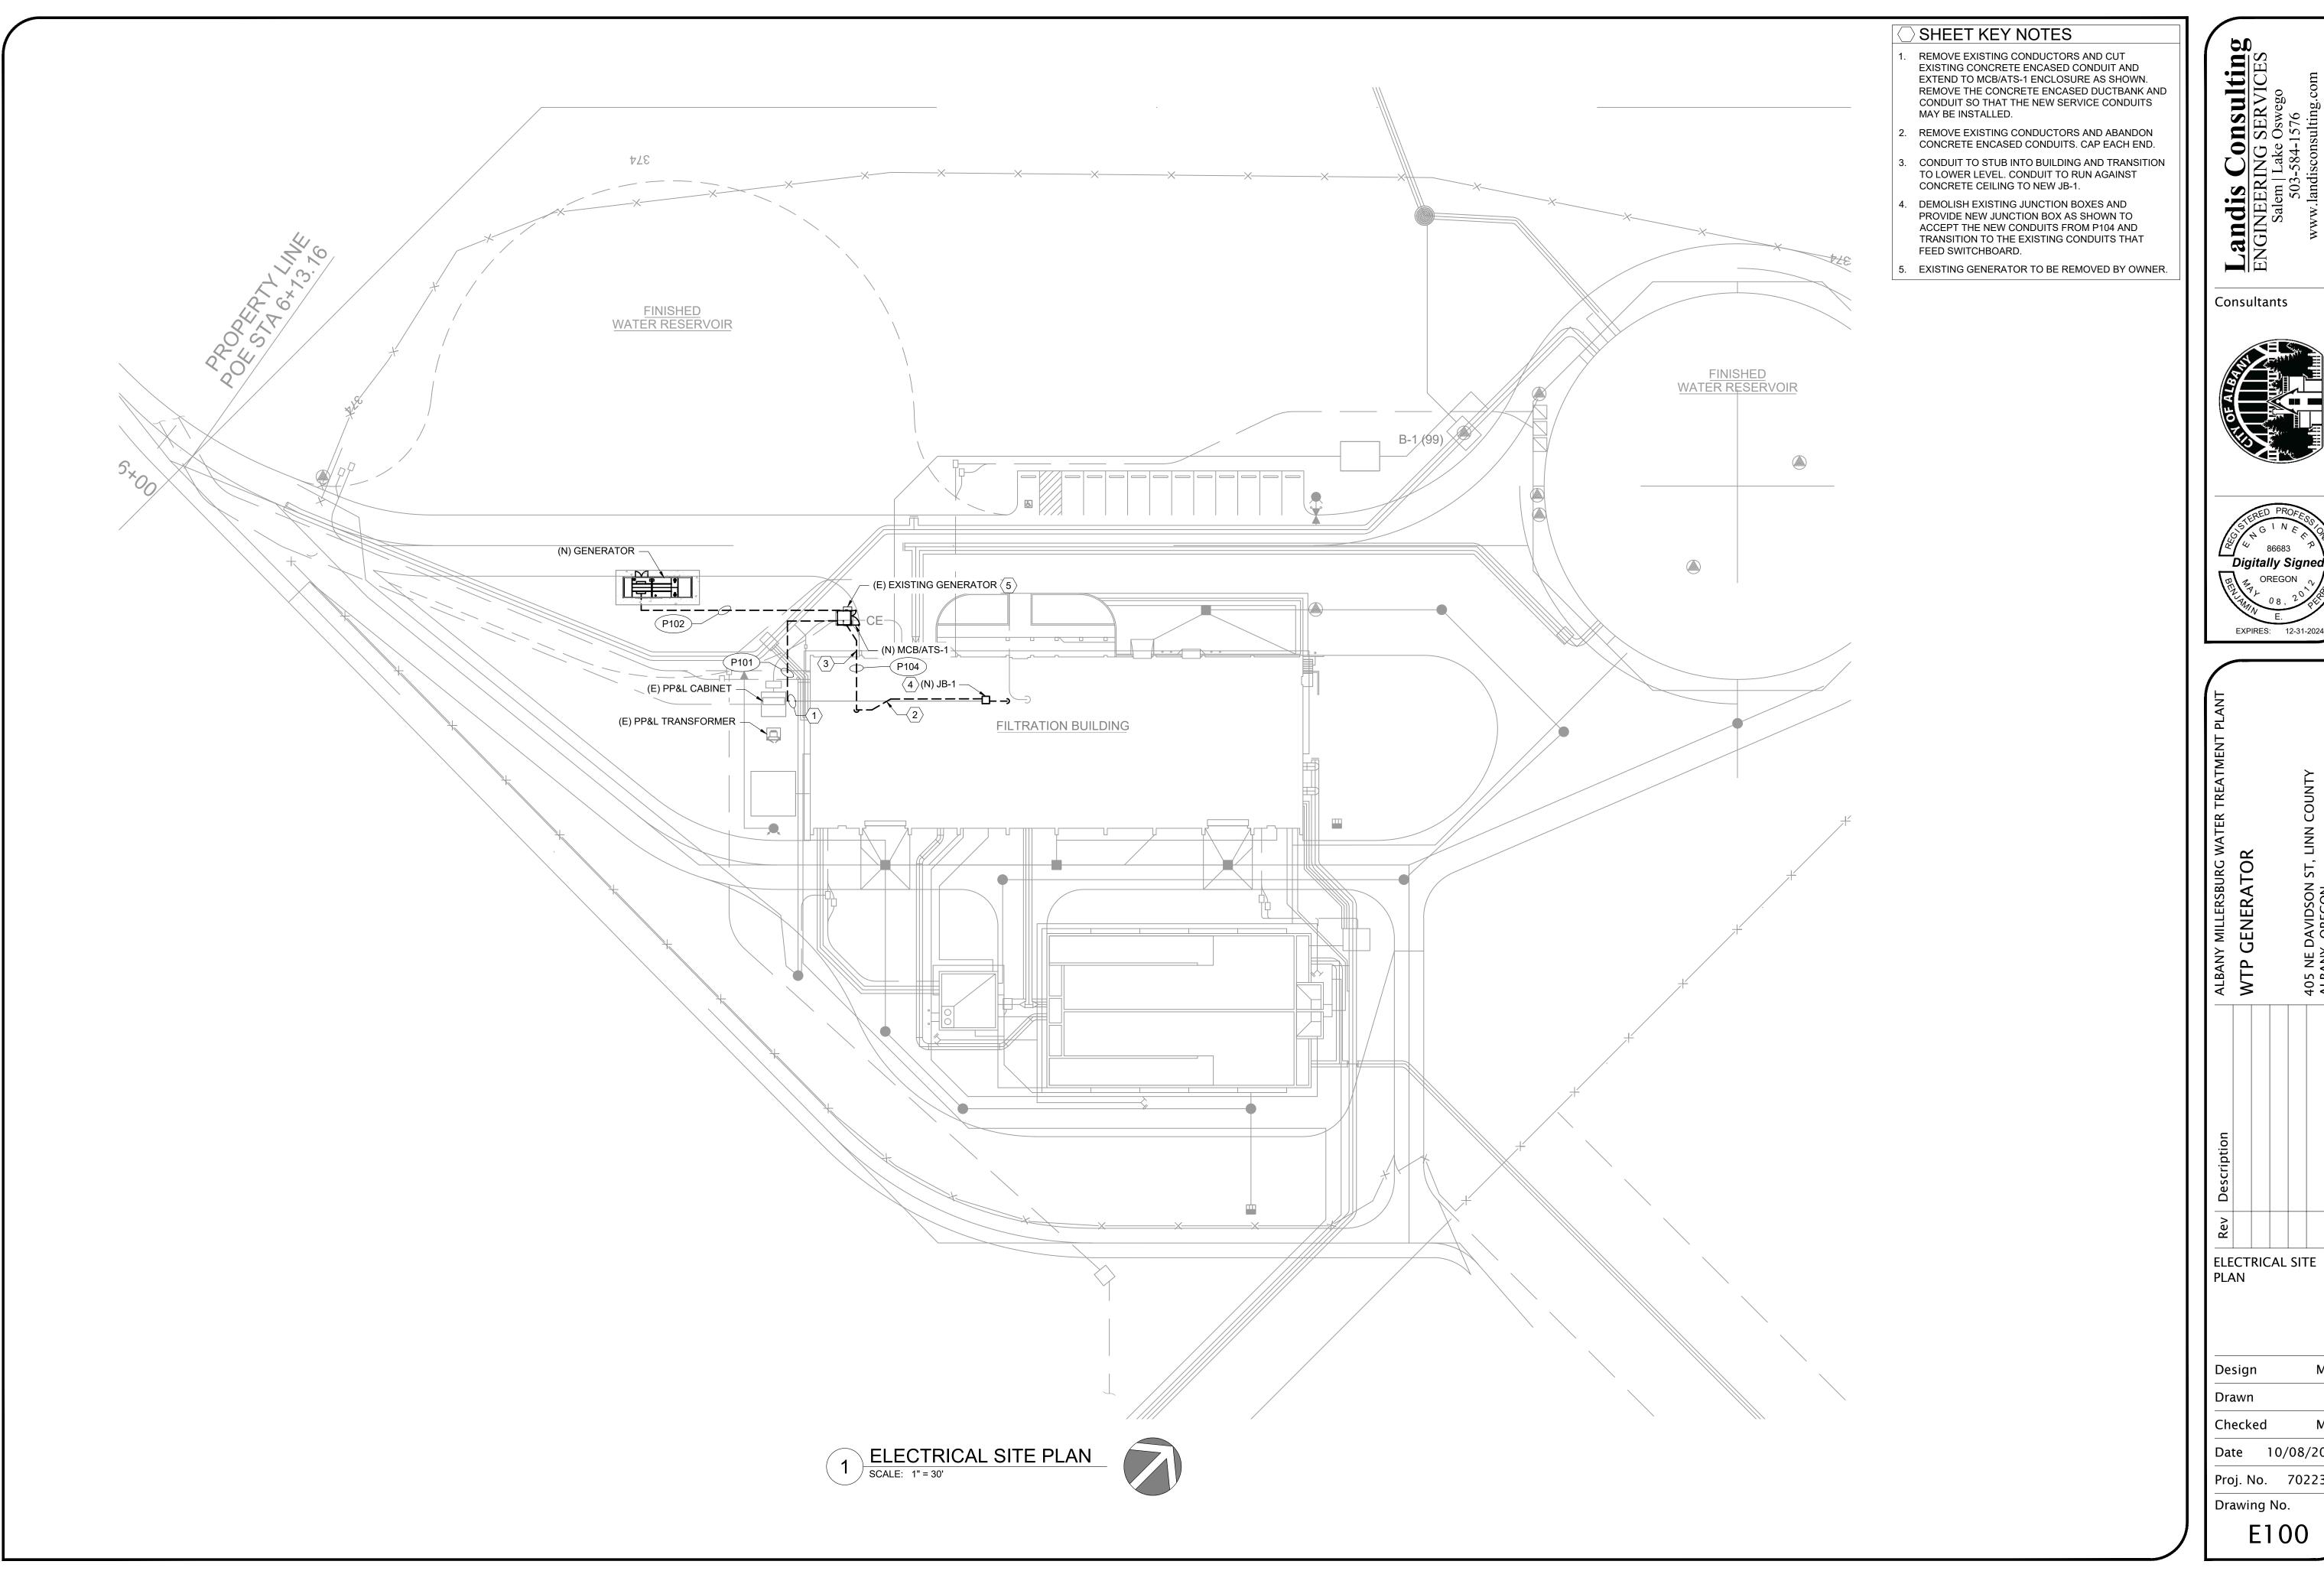


Consultants



SBURG WATER T

Design Drawn Checked Date 10/08/2024 Proj. No. 7022301

Drawing No.

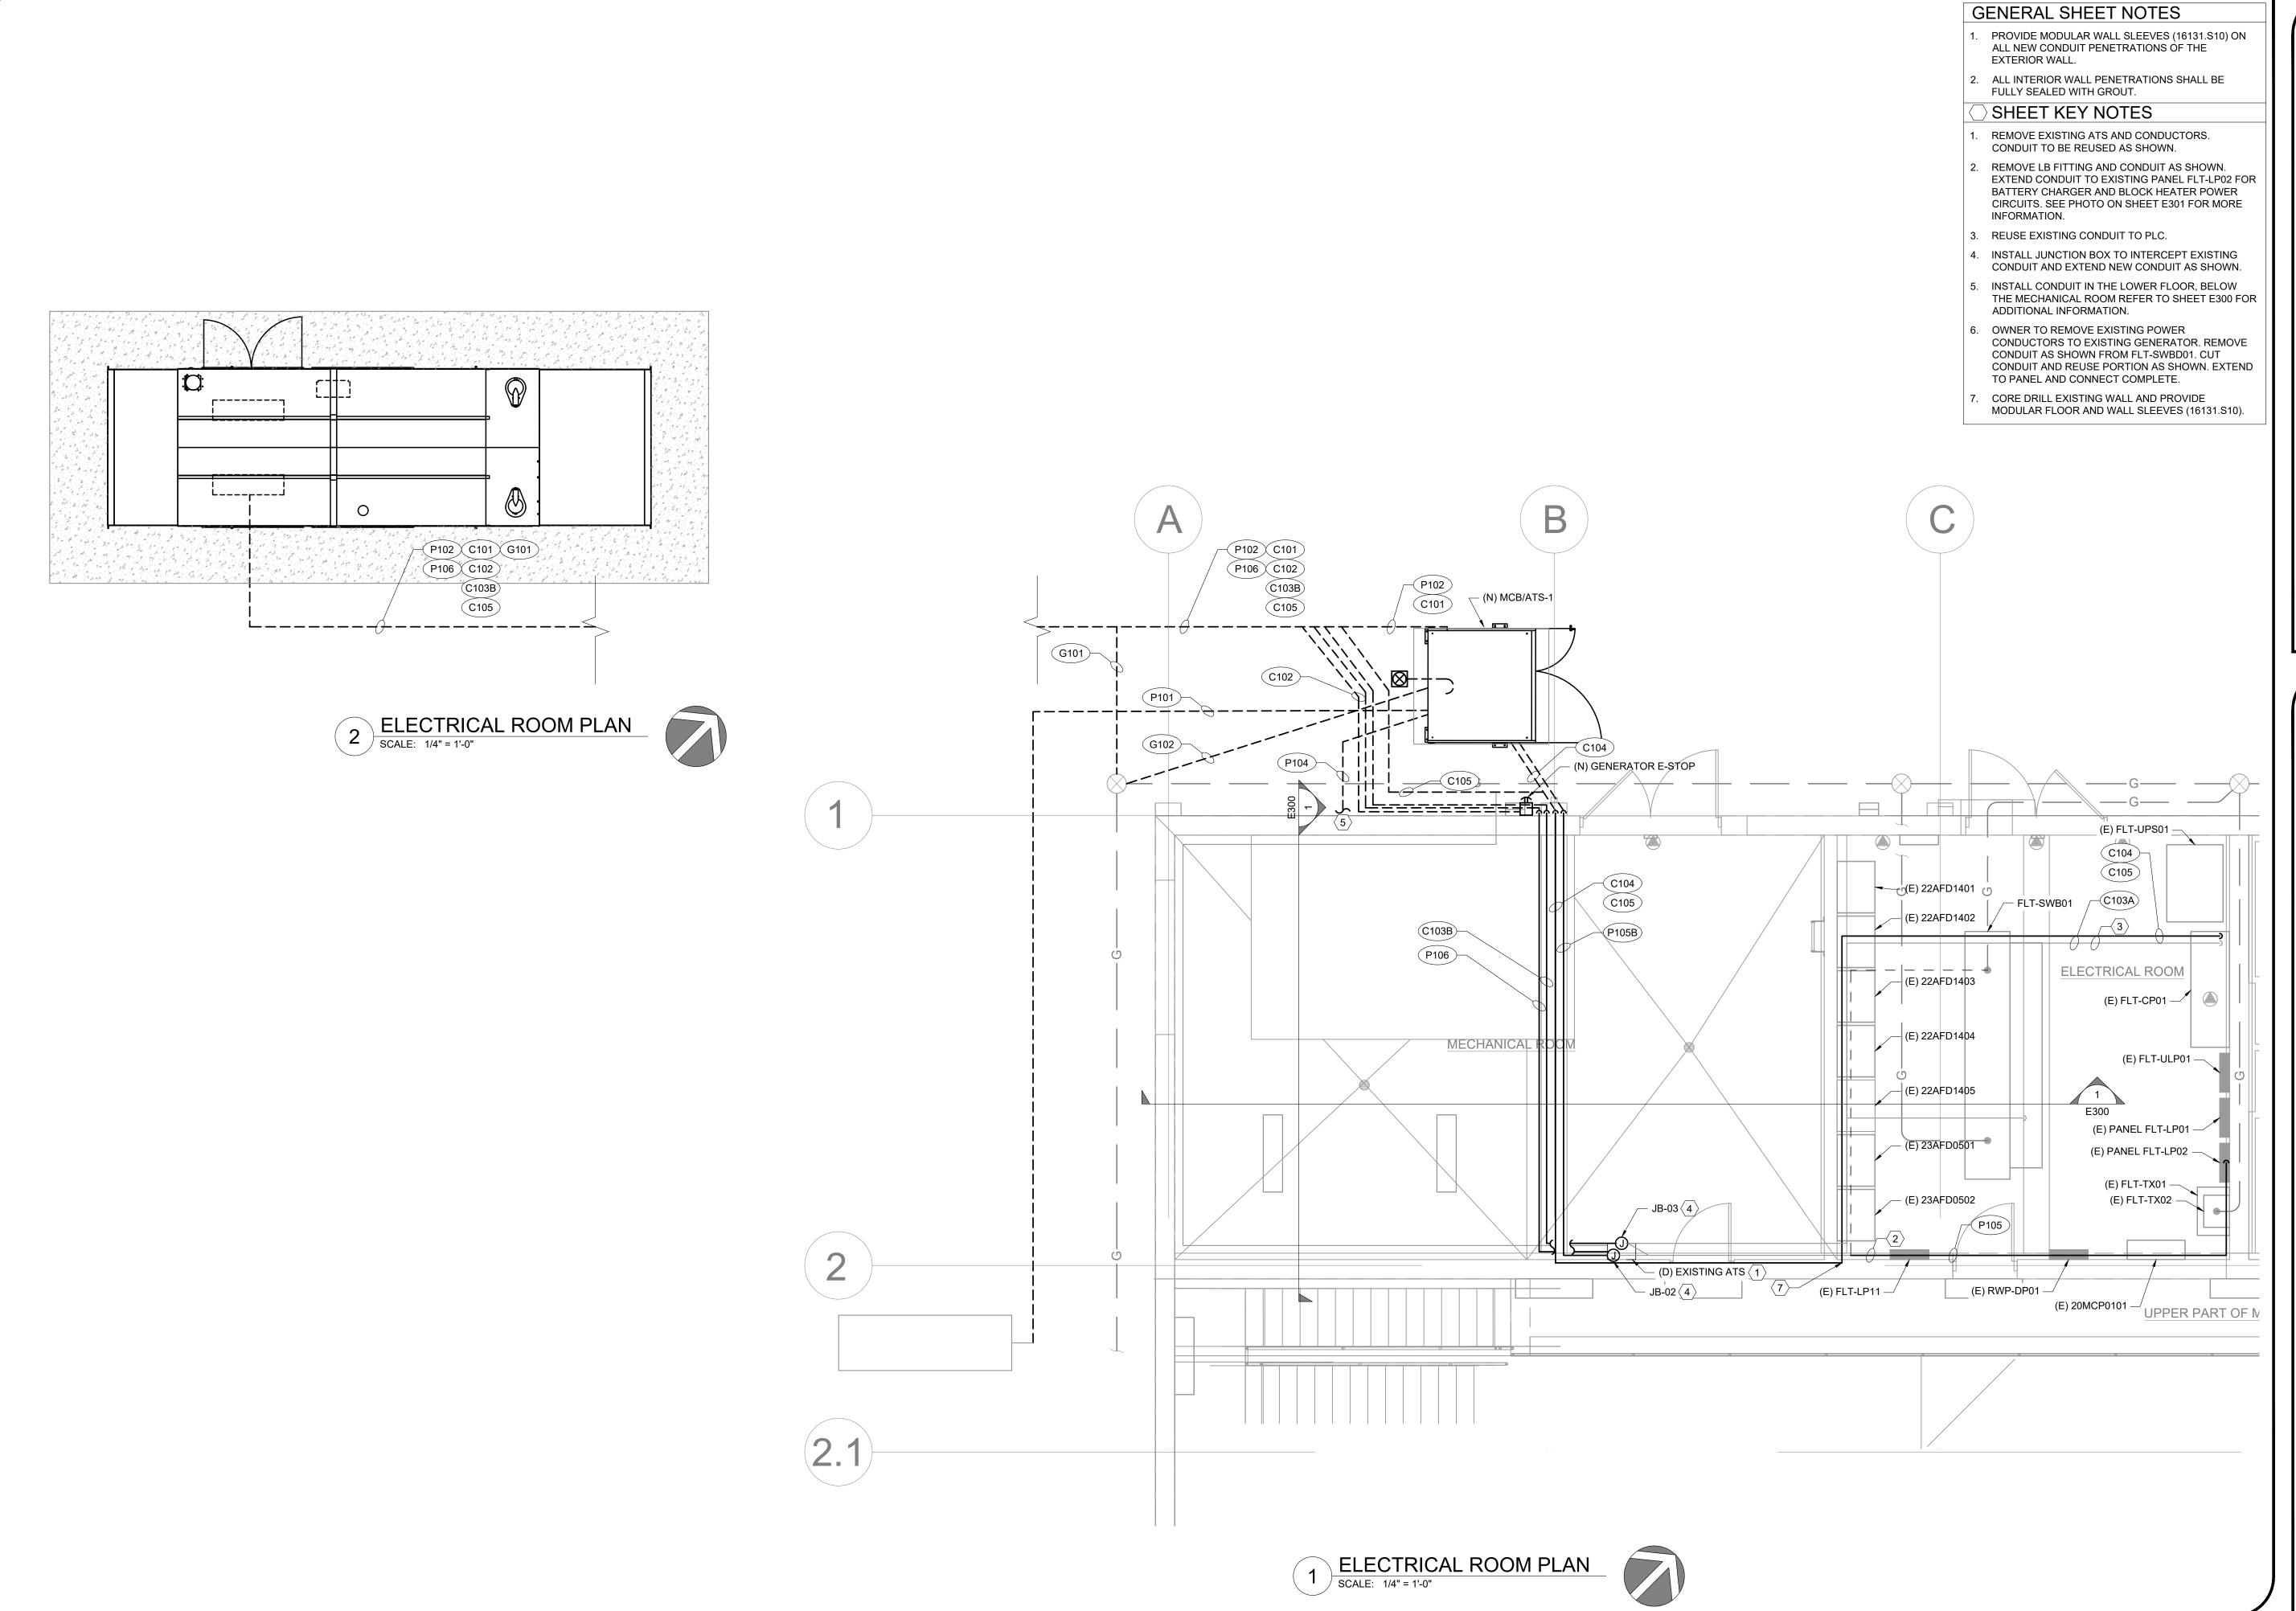

is Consulting
ERING SERVICES
em | Lake Oswego
503-584-1576
landisconsulting.com

ENGINEE Salen Solen

Consultants






ALBANY MILLERSBURG WATER TREATMENT PLANT

WTP GENERATOR

405 NE DAVIDSON ST, LINN COUNTY
ALBANY, OREGON

Design MEH
Drawn EJC
Checked MEH
Date 10/08/2024
Proj. No. 7022301

Drawing No.

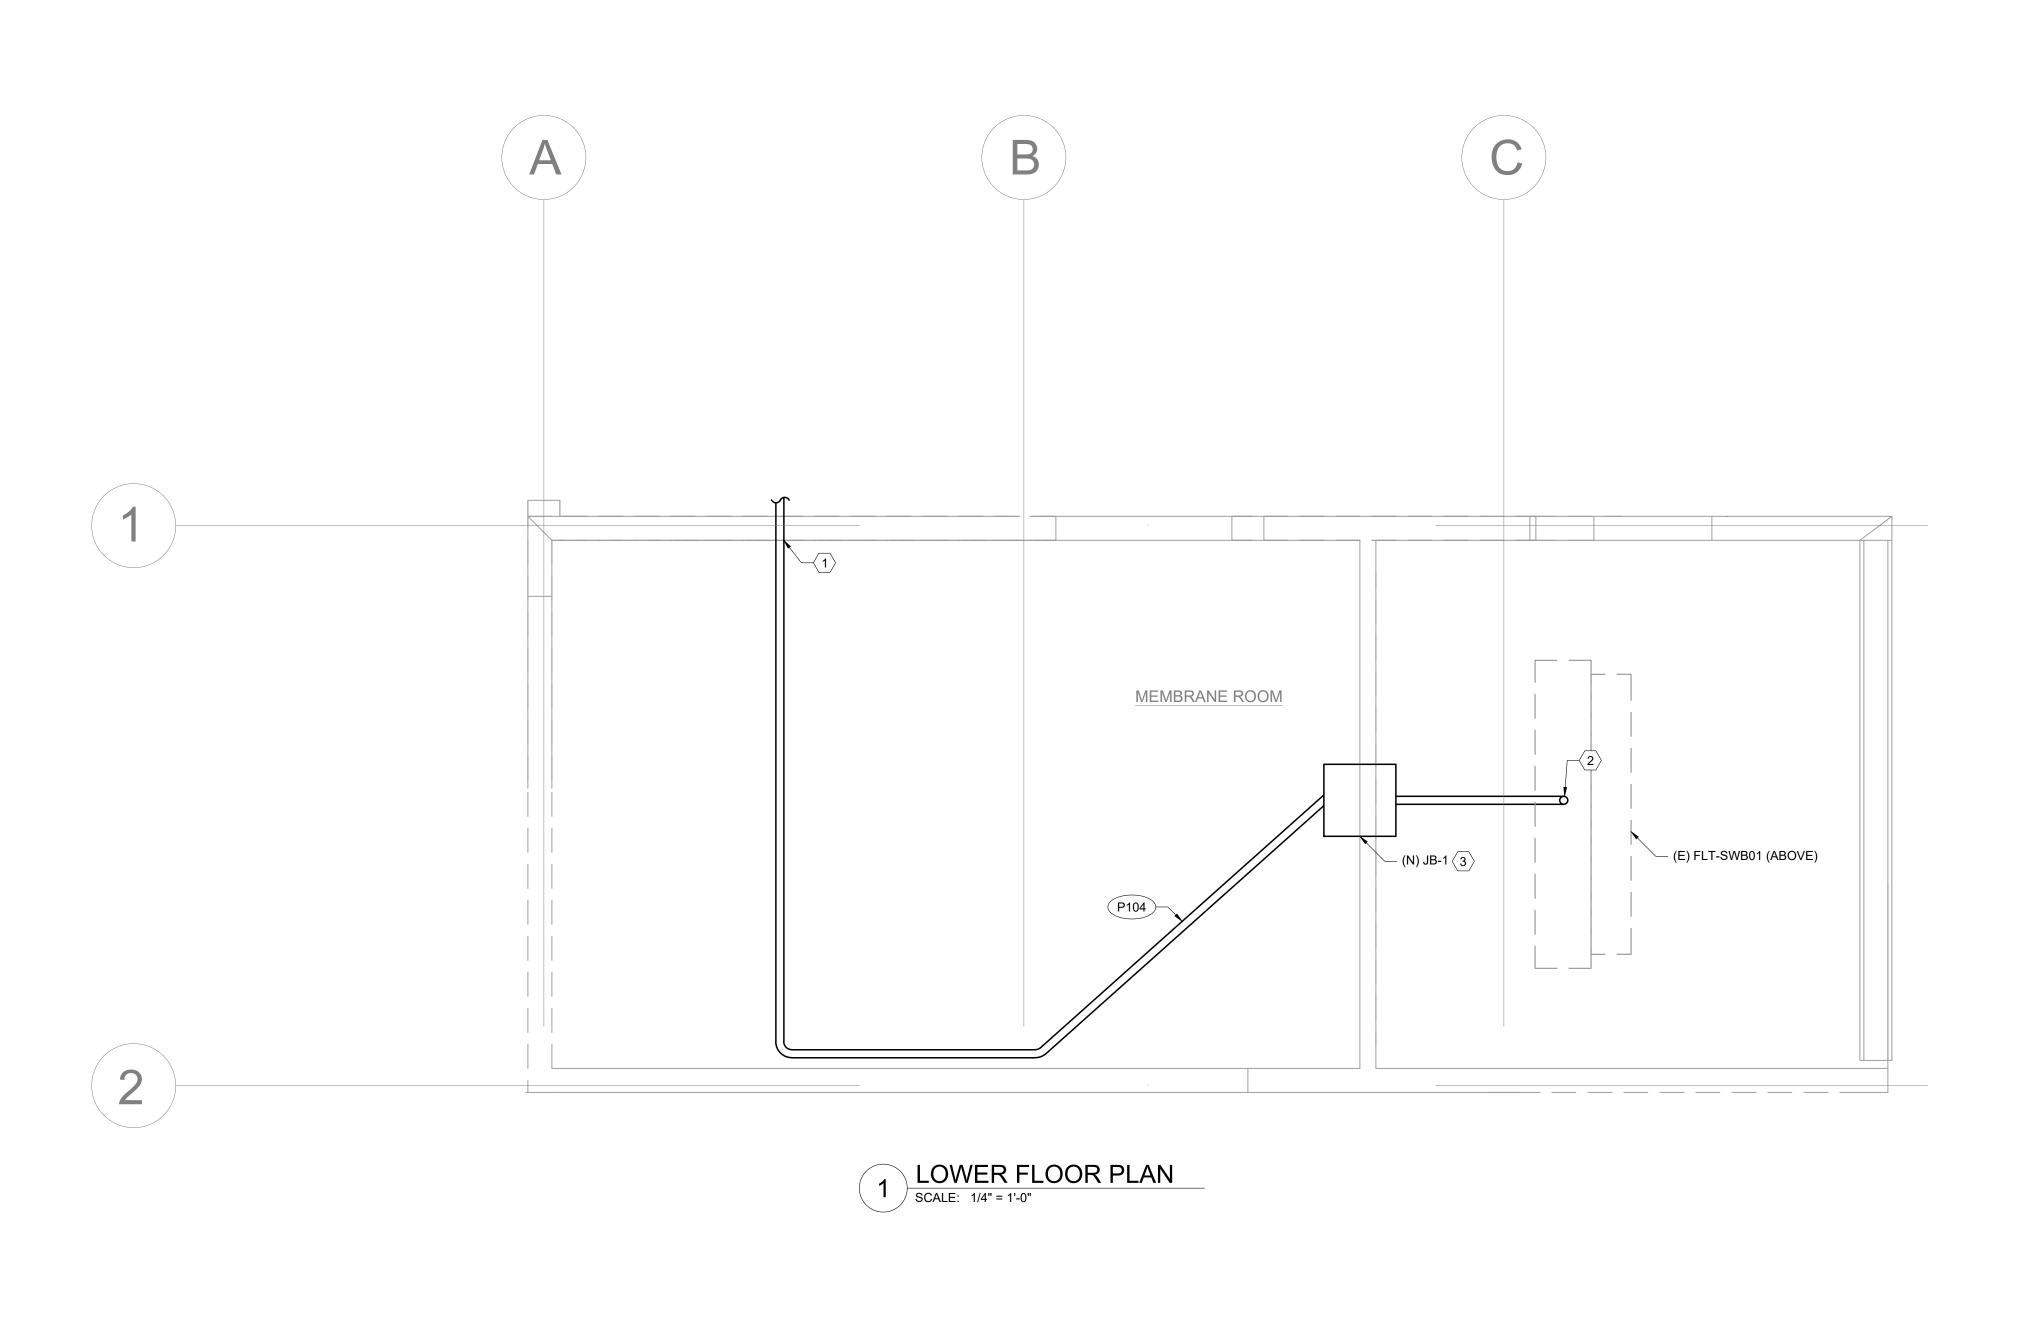

○ SHEET KEY NOTES

CORE DRILL EXISTING WALL AND PROVIDE
 MODULAR FLOOR AND WALL SLEEVES (16131.S10).

2. CONDUIT UP TO FLT-SWBD01.

3. DEMOLISH EXISTING JUNCTION BOXES AND PROVIDE NEW 36"W X 36"L X 24"D JUNCTION BOX AS SHOWN TO ACCEPT THE NEW CONDUITS FROM P104 AND TRANSITION TO THE EXISTING CONDUITS THAT FEED SWITCHBOARD.

onsultir G SERVICE ke Oswego

Salem | Lake Osv 503-584-1570 www.landisconsulti

Consultants







ALBANY MILLERSBURG WATER TREATMENT PLANT
WTP GENERATOR


405 NE DAVIDSON ST, LINN COUNTY
ALBANY, OREGON

LOWER ELECTRICAL FLOOR PLAN

Design MEH
Drawn EJC
Checked MEH
Date 10/08/2024
Proj. No. 7022301
Drawing No.

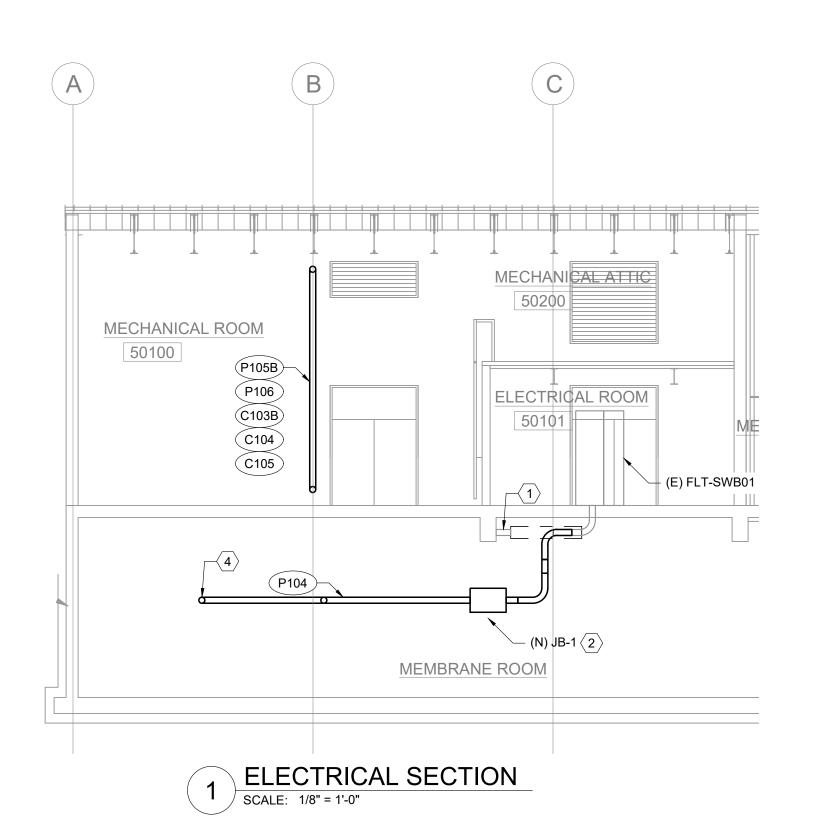

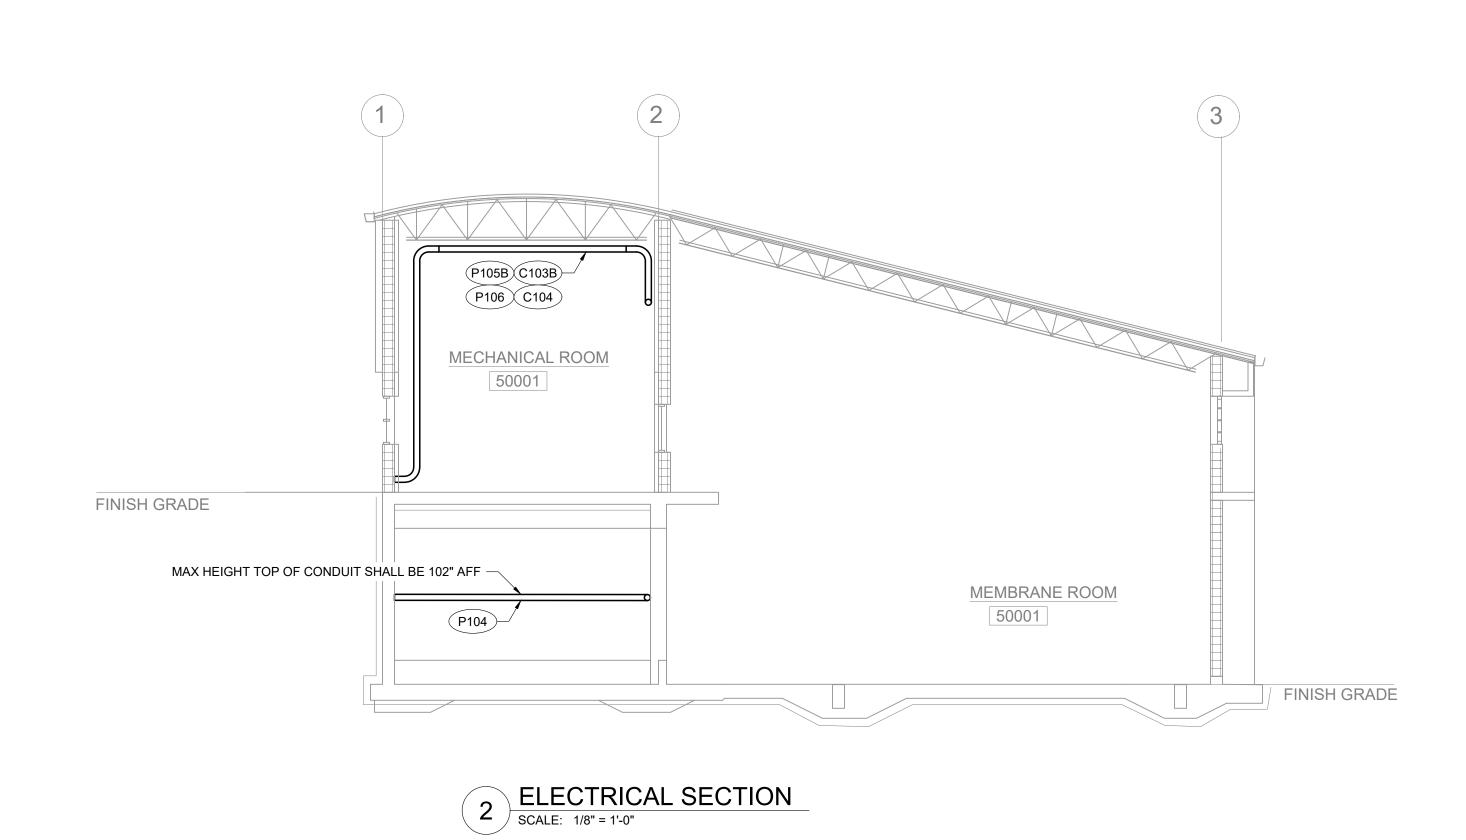

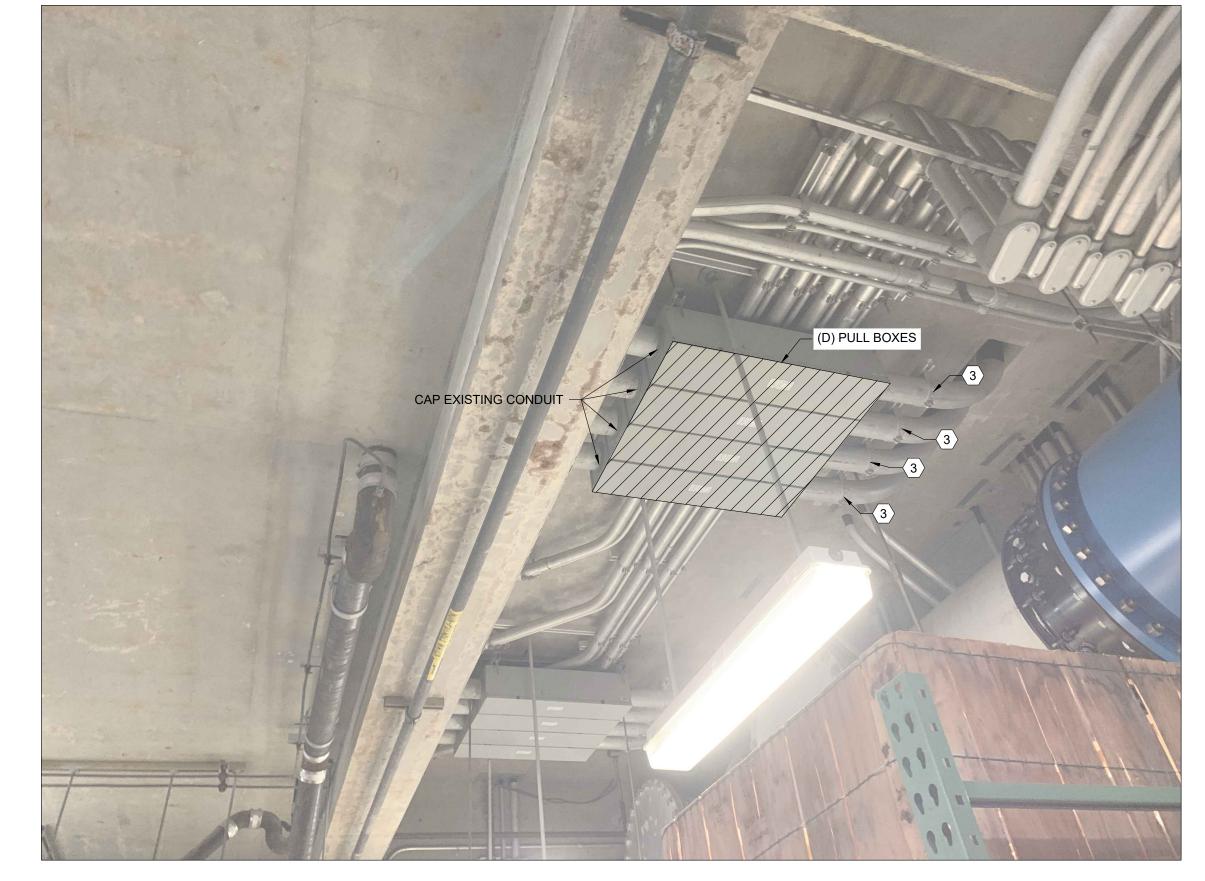

3 ELECTRICAL DEMOLITION PHOTO SCALE: NTS

○ SHEET KEY NOTES

- REMOVE EXISTING CONDUCTORS AND ABANDON CONCRETE ENCASED CONDUITS. CAP EACH END.
- 2. DEMOLISH EXISTING JUNCTION BOXES AND PROVIDE NEW 36"W X 36"L X 24"D JUNCTION BOX AS SHOWN TO ACCEPT THE NEW CONDUITS FROM P104 AND TRANSITION TO THE EXISTING CONDUITS THAT FEED SWITCHBOARD.
- 3. REMOVE EXISTING CONDUIT AT FITTING SHOWN.
- 4. CONDUIT TO EXTERIOR WALL.

Eandis Consulting

Salem | Lake Oswego 503-584-1576 www.landisconsulting.com

Consultants





ALBANY MILLERSBURG WATER TREATMENT PLANT
WTP GENERATOR

405 NE DAVIDSON ST, LINN COUNTY
ALBANY, OREGON

ELECTRICAL SECTION

Design MEH
Drawn EJC
Checked MEH
Date 10/08/2024
Proj. No. 7022301
Drawing No.



1 ELECTRICAL DETAIL PHOTO SCALE: NTS

○ SHEET KEY NOTES

REMOVE LB FITTING AND CONDUIT AS SHOWN.
EXTEND CONDUIT TO EXISTING PANEL FLT-LP02 FOR
BATTERY CHARGER AND BLOCK HEATER POWER
CIRCUITS.

RING SERVICES
n | Lake Oswego
03-584-1576

Salem | Lake Osv 503-584-1576 www.landisconsulti

Consultants





Tion

ALBANY MILLERSBURG WATER TREATMENT F

WTP GENERATOR

405 NE DAVIDSON ST, LINN COUNTY
ALBANY, OREGON

ELECTRICAL DETAIL PHOTO

Design MEH

Drawn EJC

Checked MEH

Date 10/08/2024

Proj. No. 7022301

Drawing No.

	PANEL NAME: FLT LP02							LOCATION:	ELECTRICAL	ROOM							
	<u>VOLT/PHASE:</u> 208/120V, 3Ø							FED FROM:	FLT LP01								
	NUM. POLES: 42							BREAKER I	MOUNTING: I	BOLTED							
	AIC RATING: 10,000							MAIN BREA	KER AMPS:	100							
	NOTES: EXISTING PANEL							BUS RATING	G AMPS: 2	250							
	REF. KEY NOTE #:							SPD:		YES (1)							
ES	LOAD DESCRIPTION	LOAD TYPE	VA L1	VA L2	VA L3	TRIP RATING	CIRCUIT NUMBER	CIRCUIT NUMBER	TRIP RATING	VA L1	VA L2	VA L3	LOAD TYPE	LOAD DESCRIPTION	NOTE		
	DODTO MEGUL ELECT MEZZ			LZ	L3	AMPS	NUMBER		AMPS		LZ	L3		DODTO MENIDDANE DOOM			
	RCPTS MECH, ELECT, MEZZ RCPTS TOILET, EXTERIOR	R	720	720		20	3	2	20	720	720		R R	RCPTS MENBRANE ROOM RCPTS MENBRANE ROOM			
	RCPTS TOILET, EXTERIOR RCPTS LOBBY, EXTERIOR	R		720	500	20	5	6	20		720	360	R	MULTI OUTLET-PARTS			
	MULTI OUTLET-ANALYZER ROOM	R	720		500	20	7	8	20	540		300	R	MULTI OUTLET-PARTS			
	MULTI OUTLET-ANALYZER ROOM		720	720		20	9			540	360			MULTI OUTLET-PARTS			
		R		720	720			10	20		360	000	R				
	RCPTS UCR/F ANALYZER RM.	R	200		720	20	11	12	20	000		900	R	RCPTS PARTS, TANKS			
	RCPTS DWS ANALYZER RM.	R	360	70.0		20	13	14	20	900	4.000		R	RCPTS BLOWER ROOM	-		
	RCPTS ANALYZER EAST WALL	R		720		20	15	16	20		1,000		E	ATS SPACE HEATER	1		
	RCPTS ANALYZER RM.	R			360	20	17	18	20			900	R	RCPTS MEM RM EAST WALL			
	RCPTS FLOURIDE, EXTERIOR	R	720			20	19	20	20	900			R	RCPTS MEM RM SOUTH WALL			
	RCPTS SODIUM HYPO	R		720		20	21	22	20		900		R	RCPTS MEM RM WEST WALL	_		
	RCPTS UPPER WALKWAY	R			720	20	23	24	20			1,000	R	RCPTS SHOP			
	92UH6401	E	360			20	25	26		1,000			R				
	92UH9501	E		657		20	27	28	20		360		E	SIT_CP01			
	92UH7401, 92UH5401	E			230	20	29	30				1,000	E				
	92EF7501	E	506			20	31	32	20	1,000			E	FRONT GATE SIT-GAT01			
	92EF5501	E		700		20	33	34			1,000		Е				
2	BLOCK HEATER	HEATER			1,000	20	35	36	20			1,100	Е	MICROWAVE OVEN			
	BEGGKTIERK	E	1,000			20	37	38	20	1,200			E	REFRIGERATOR			
	BATTERY CHARGER	E		1,200		20	39	40	20		-			SPARE			
	92HCP0201	Е			-	20	41	42	20			100	Е	LIGHTING CONTROL POWER			
	TOTAL LOAD		4,386	5,437	3,530			TOTAL LOA	D: [6,260	4,340	5,360					
	COMBINED LOAD		10,646	9,777	8,890	CONNE	CTED LOAD:	29,313		DEN	MAND LOAD:	25,863					
						1			I	DEM	IAND AMPS:	72					
	Load Type Key			Demand Fac	etor		Connected L	oad	Demand Load	4							
				100% First		thereafter	16,900		13,450	<u>=</u>							
	R General Purpose Re	L Lighting		125% Load			0		0								
	L Lighting			1250/ Load	125% Load 100% Load					0							
							0		0								
	L Lighting M1 Largest Motor M Motor A Appliance			100% Load 100% Load			0		0								
	L Lighting M1 Largest Motor M Motor			100% Load			0 0 0		0 0 0		XX	- Units of Eq	uipment - See	e NEC Table 220.56			
	L Lighting M1 Largest Motor M Motor A Appliance H HVAC K Kitchen E Equipment			100% Load 100% Load 100% Load 100% Load 100% Load			0 12,413		0 0 0 0 12,413		XX	- Units of Eq	uipment - See	e NEC Table 220.56			
	L Lighting M1 Largest Motor M Motor A Appliance H HVAC K Kitchen			100% Load 100% Load 100% Load 100% Load			0		0 0 0 0 12,413 0		XX	- Units of Eq	μipment - Seα	e NEC Table 220.56			

GENERAL SHEET NOTES

EXISTING PANEL IS SIEMENS P1 SERIES.
 CONTRACTOR SHALL FIELD VERIFY EXACT MODEL
 NUMBER PRIOR TO ORDERING NEW CIRCUIT
 BREAKERS.

○ SHEET KEY NOTES

 EXISTING PANEL HAS INTERNAL SPD DEVICE THAT DOES NOT TAKE EXISTING BREAKER SPACE. Indis Consulti INEERING SERVICE Salem | Lake Oswego

Consultants





ALBANY MILLERSBURG WATER TREATMENT PLANT
WTP GENERATOR

405 NE DAVIDSON ST, LINN COUNTY
ALBANY, OREGON

Design MEH
Drawn EJC
Checked MEH
Date 10/08/2024
Proj. No. 7022301

PANEL SCHEDULE

Drawing No.